
HUNT RESIDENCE

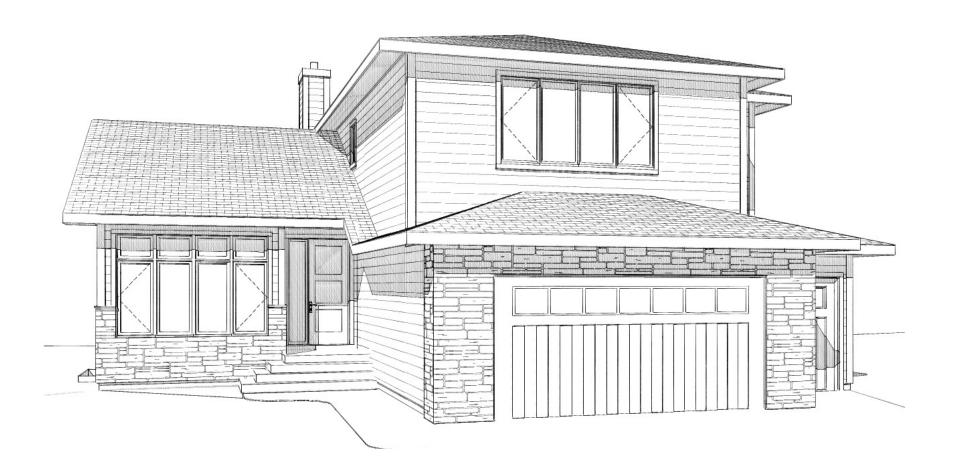

LIST OF DRAWINGS

AO1 TITLE PAGE

A02 NOTES/LEGENDS

A03 MAIN & UPPER FLOOR PLANS

A04 LOWER FLOOR & ROOF PLANS

A05 ELEVATIONS A06 ELEVATIONS

A07 BUILDING SECTION

EO 1 MAIN & UPPER FLOOR ELECTRICAL

EO2 LOWER FLOOR ELECTRICAL



PROJECTNAME:
HUNT RESIDENCE
19/03/2010

SHEET TITLE:

TITLE PAGE

SCALE:

A0

THESE DRAWINGS MAY NOT BE USED OR DUPLICATED WITHOUT EXPRESS PERMISSION OF EVANS 2 DE SIGN GROUP LTD. ALL RIGHTS ARE RESERVED

EVANS 2 DESIGN GROUP LTD., HAS TAKEN GREAT CARE IN THE PREPARATION OF THESE CONSTRUCTION DRAWINGS. HOWEVER SINCE BUILDING CODES MAY VARY WITH LOCATIONS AND MAY CHANGE WITHOUT NOTICE. EVANS 2 DESIGN GROUP LTD. DOES NOT GUARANTEE COMPLIANCE MITH ANY SPECIFIC CODES OR ORDINANCES, PURCHASERS ARE RESPONSIBLE FOR VERIFYING COMPLIANCE MITH LOCAL BUILDING CODES AND ORDINANCES AND FOR ANY MODIFICATIONS TO THE DRAWINGS THAT MAY NEED TO BE MADE TO COMPLY. PURCHASERS ARE ALSO RESPONSIBLE FOR VERIFYING SITE AND SOIL CONDITIONS AS MELL AS ALL DIMENSIONS AND SQUARE FOOTAGE CALCULATIONS BEFORE BEGINNING CONSTRUCTION. DESIGNERPLANS INC. SHALL NOT BE HELD LIABLE AND ASSUME

THESE DRAWINGS ARE THE PROPERTY OF EVANS 2 DESIGN GROUP LTD. AND MAY NOT BE USED OR REPRODUCED WITHOUT PROPER AUTHORIZATION.

GENERAL NOTES

- -ALL CONSTRUCTION IS TO COMPLY WITH THE LATEST EDITION OF THE LOCAL BUILDING CODE, AS WELL AS ALL OTHER CODES, BY-LAWS, AND ORDINANCES.
- -TRUSS MANUFACTURER TO REPORT ALL CHANGES THAT AFFECT HEIGHTS, CLEARANCES, AND BEARING POINTS TO THE OMNER / BUILDER PRIOR TO MANUFACTURE.
- -THESE PLANS SHOULD BE STUDIED AND USED IN THEIR ENTIRETY AS INFORMATION VITAL TO EACH STAGE OF CONSTRUCTION MAY APPEAR ONCE, OR ON MULTIPLE SHEETS.
- IF THE CONTRACTOR DISCOVERS A CONSTRUCTION DEVIATION FROM THE DRAWINGS, IT IS THE CONTRACTORS RESPONSIBILITY TO BRING THAT ISSUE INTO COMPLIANCE.
- -THE GENERAL CONTRACTOR IS TO BE HELD SOLELY RESPONSIBLE FOR ALL WORK SHOWN OR REASONABLY IMPLIED BY THESE DRAWINGS, CONTRACTOR IS TO CONFIRM ALL DIMENSIONS, SITE CONDITIONS, DETAILS, AND SHALL IMMEDIATELY NOTIFY EVANS 2 DESIGN GROUP LTD. IN WRITING OF ANY DISCREPANCIES.
- -DRAWINGS SHALL NOT BE SCALED, USE LABELED DIMENSIONS ONLY.

-PLANS, ELEVATIONS AND BUILDING SECTIONS TAKE PRECEDENCE OVER LARGER SCALED DRAMINGS. LARGER SCALED DRAWINGS SUCH AS DETAILS AND WALL SECTIONS ARE TO BE USED AS A GUIDELINE AND DO NOT NECESSARILY REFLECT THIS SPECIFIC

-EVANS 2 DESIGN GROUP LTD. IS NOT RESPONSIBLE FOR EQUIPMENT OR MATERIALS NOT SPECIFIED IN THESE DRAWINGS.

ELECTRICAL LEGEND

→ CEILING MOUNTED FIXTURE .

SMALL HALOGEN RECESSED POT

RECESSED PAR LAMP (POT LIGHT)

MALL SCONCE - HEIGHT T.B.D.

(F) CEILING FAN

X ZENON STRIP / U/S CABINET PUCK

MP SHOWER POT \Rightarrow 110V OUTLET

220 @ 220 V OUTLET

GFI GFI OUTLET

MP

EXTERIOR WATERPROOF OUTLET

PHONE OUTLET TΥ TY OUTLET

SMITCH

3 MAY SMITCH

(SD) SMOKE DETECTOR

H HOSE BIB

STRUCTURAL LEGEND

SF 18" x 8" STRIP FOOTING PF 1 30" x 30" x 8" PAD FOOTING 36" x 36" x8" PAD FOOTING LBM LOAD BEARING WALL BP BEAM POCKET POINT LOAD ABOVE DB DROPPED BEAM FLUSH FRAMED BEAM DJ GT GIRDER TRUSS LEDGER BOARD

PLAN NOTES

-PROVIDE FOUNDATION WATERPROOFING WHERE EXTERIOR GRADE IS ABOVE CRAWL SPACE OR BASEMENT SLAB AND INSTALL 4" PERFORATED PLASTIC FOUNDATION DRAI AND SLOPE TO STORM SEWER, ON SITE DRY WELL OR NATURAL DRAINAGE COURSES.

-BUILDER TO PROVIDE EXTERIOR FLASHING AROUND ALL CHIMNEYS, AT ALL CHANGES IN EXTERIOR MATERIALS, ABOVE ALL WINDOWS AND DOORS, AT ALL INTERSECTIONS BETWEEN WALLS AND ROOF, AND IN ALL ROOF VALLEYS, ANY ADDITIONAL BUILDING EXTERIOR SURFACE PENETRATIONS WITH POTENTIAL EXPOSURE TO WEATHER SHALL BE FLASHED AND / OR CAULKED AS PER CODE AND / OR INDUSTRY RECOGNIZED PROPER CONSTRUCTION TECHNIQUES, ALL ROOF SHINGLE FLASHING AGAINST A VERTICAL SURFACE MUST BE FLASHED WITH STEP FLASHING.

- MINDOM STYLES AND SIZES SHOWN ARE TO BE USED AS A **GUIDELINE** ONLY, EXACT DIMENSIONS, ROUGH OPENINGS AND DETAILS OF EXTERIOR DOORS AND MINDOMS ARE TO BE SUPPLIED BY THE MINDOM MANUFACTURER AND APPROVED BY HOMEOMNER. TOP OF EXTERIOR DOORS / TRANSOM SHOULD ALIGN MITH MINDOMS, CONTRACTOR SHALL BE RESPONSIBLE FOR SELECTING MINDOMS THAT MEET EGRESS AND TEMPERED GLASS REQUIREMENTS, ALL FRENCH DOORS, SLIDING GLASS DOORS, AND SHOWER ENCLOSURES AND DOORS SHALL BE TEMPERED GLASS WHERE REQUIRED.

-ALL ANGLED WALLS ARE AT 45 DEGREES UNLESS NOTED OTHERWISE..

-DOOR FROM HOUSE TO GARAGE TO INCLUDE WEATHER-STRIPPING AND SELF-CLOSER DEVICE. ALL EXTERIOR DOORS AND MINDOWS TO INCLUDE WEATHER-STRIPPING AS PER LOCAL BUILDING CODES AND GOOD BUILDING PRACTICES.

- KITCHEN LAYOUT IS TO BE USED AS A GUIDELINE ONLY, KITCHEN SUPPLIER TO HAVE FINAL LAYOUT AND DETAILS APPROVED BY HOMEOWNER.

- FINISHED FLOORING MATERIALS - SPECIFIED BY THE OWNER, TO BE FLUSH AND LEVEL, BUILDER TO BUILD UP FLOORS AS REQUIRED

- BLOCKING IS TO BE PROVIDED AT ALL CABINET LOCATIONS, AND ALL HARDWARE LOCATIONS INCLUDING TOWEL BARS AND TOILET PAPER DISPENSERS. CAVITIES TO PROVIDED AT RECESSED MEDICINE CABINET LOCATIONS. WALL TO BE RECESSED MINIMUM 2" BEHIND FRIDGE.

-BUILDER IS TO ENSURE THAT ROOF IS ADEQUATELY VENTED AS PER LOCAL BUILDING CODE. VENTS NOT TO BE PLACED IN HIGHLY VISIBLE LOCATIONS.

- BUILDER TO ENSURE FRAMING SUITS MECHANICAL (FIREPLACES), PLUMBING AND ELECTRICAL FIXTURES SPECIFIED AND SUPPLIED BY OTHERS.

- IT IS THE BUILDERS RESPONSIBILITY TO PROVIDE ADEQUATE ROOM FOR MECHANICAL CHASES, PLUMBING STACKS, ETC ...

- BUILDER TO DETERMINE LOCATIONS WHERE SERVICES ENTER AND CONFIRM FINAL LOCATIONS WITH BUILDING OWNER.

-HEIGHTS OF INTERIOR DOORS & PANEL STYLE TO BE DETERMINED BY HOME OWNER

- LOCATION OF MECHANICAL EQUIPMENT IS APPROXIMATE. FINAL LOCATION TO BE DETERMINED ON SITE AND APPROVED BY HOMEOWNER. EQUIPMENT TO BE SIZED AND SUPPLIED BY OTHERS.

- ALL STRUCTURAL INFORMATION IS TO BE USED AS A **GUIDELINE** ONLY. ALL STRUCTURE INCLUDING FLOORS, FOOTINGS, BEAMS, LINTELS, FOOTS, TRUSSES, ETC... TO BE SIZED AND SUPPLIED BY OTHERS TO MEET LOCAL STANDARDS / CODES AND REGULATIONS, LINTEL / BEAM REQUIRED @ ALL OPENINGS IN EXTERIOR AND LOAD

- ELECTRICAL LAYOUT IS TO BE USED AS A **GUIDELINE** ONLY. FINAL PLACEMENT AND SPECIFICATION OF FIXTURES TO BE APPROVED BY HOMEOWNER. ELECTRICAL WIRING AND PLACEMENT OF OUTLETS AND SWITCHES TO BE DONE TO MEET LOCAL BUILDING CODES AND REGULATIONS. BUILDER TO PROVIDE ADEQUATE ELECTRICAL SERVICE FOR ALL APPLIANCES AND MECHANICAL EQUIPMENT AS REQUIRED

SECTION / ELEVATION NOTES

-GRADE ELEVATIONS SHOWN DO NOT NECESSARILY REFER TO ANY SPECIFIC PIECE OF PROPERTY, THEY ARE FOR ILLUSTRATION PURPOSES ONLY AND MAY VARY. BUILDER IS RESPONSIBLE FOR ADAPTING THESE DRAWINGS TO SUIT THE EXISTING TOPOGRAPHY OF THE SITE..

PROVIDE FOUNDATION WATERPROOFING WHERE EXTERIOR GRADE IS ABOVE CRAY PACE OR BASEMENT SLAB AND INSTALL 4" PERFORATED PLASTIC FOUNDATION DR AND SLOPE TO STORM SEWER, ON SITE DRY WELL OR NATURAL DRAINAGE COURSES

-BUILDER TO PROVIDE EXTERIOR FLASHING AROUND ALL CHIMNEYS, AT ALL CHANGES IN EXTERIOR MATERIALS, ABOVE ALL WINDOWS AND DOORS, AT ALL INTERSECTIONS BETWEEN WALLS AND ROOF, AND IN ALL ROOF VALLEYS, ANY ADDITIONAL BUILDING EXTERIORS SURFACE PENETRATIONS WITH POTENTIAL EXPOSURE TO MEATHER SHALL BE FLASHED AND / OR CAULKED AS PER CODE AND / OR INDUSTRY RECOGNIZED PROPER CONSTRUCTION TECHNIQUES, ALL ROOF SHINGLE FLASHING AGAINST A VERTICAL SURFACE MUST BE FLASHED WITH STEP FLASHING.

WINDOW STYLES AND SIZES SHOWN ARE TO BE USED AS A **GUIDELINE** ONLY, EXACT DIMENSIONS, ROUGH OPENINGS AND DETAILS OF EXTERIOR DOORS AND MINDOWS ARE TO BE SUPPLIED BY THE WINDOW MANUFACTURER AND APPROVED BY HOMEOWNER. TOP OF EXTERIOR DOORS / TRANSOM SHOULD ALIGN WITH WINDOWS. CONTRACTOR E RESPONSIBLE FOR SELECTING WINDOWS THA GLASS REQUIREMENTS. ALL FRENCH DOORS, SLIDING GLASS DOORS, AND SHOWER ENCLOSURES AND DOORS SHALL BE TEMPERED.

-BUILDER IS TO ENSURE THAT ROOF IS ADEQUATELY VENTED AS PER LOCAL BUILDING CODE. VENTS NOT TO BE PLACED IN HIGHLY VISIBLE LOCATIONS.

-DOWNSPOUTS ARE NOT SHOWN FOR CLARITY, CONTRACTOR TO VERIFY LOCATIONS

-CHIMNEYS SHALL EXTEND AT LEAST 2'-0" HIGHER THAN ANY PORTION OF THE BUILDING WITHIN 10'-0" OR AS PER LOCAL BUILDING CODE.

- ALL STRUCTURAL INFORMATION IS TO BE USED AS A **GUIDELINE** ONLY. ALL STRUCTURE INCLUDING FLOORS, FOOTINGS, BEAMS, LINTELS, POSTS, TRUSSES, ETC... TO BE SIZED AND SUPPLIED BY OTHERS TO MEET LOCAL STANDARDS / CODES AND REGULATIONS LINTEL / BEAM REQUIRED @ ALL OPENINGS IN EXTERIOR AND LOAD BEARING WALLS.

- BUILDER TO DETERMINE SERVICE LOCATIONS AND CONFIRM FINAL LOCATIONS WITH BUILDING OWNER




PROJECT NAME:


HUNT RESIDENCE 19/03/2010

SHEET TITLE:


NOTES/LEGENDS

SCALE:

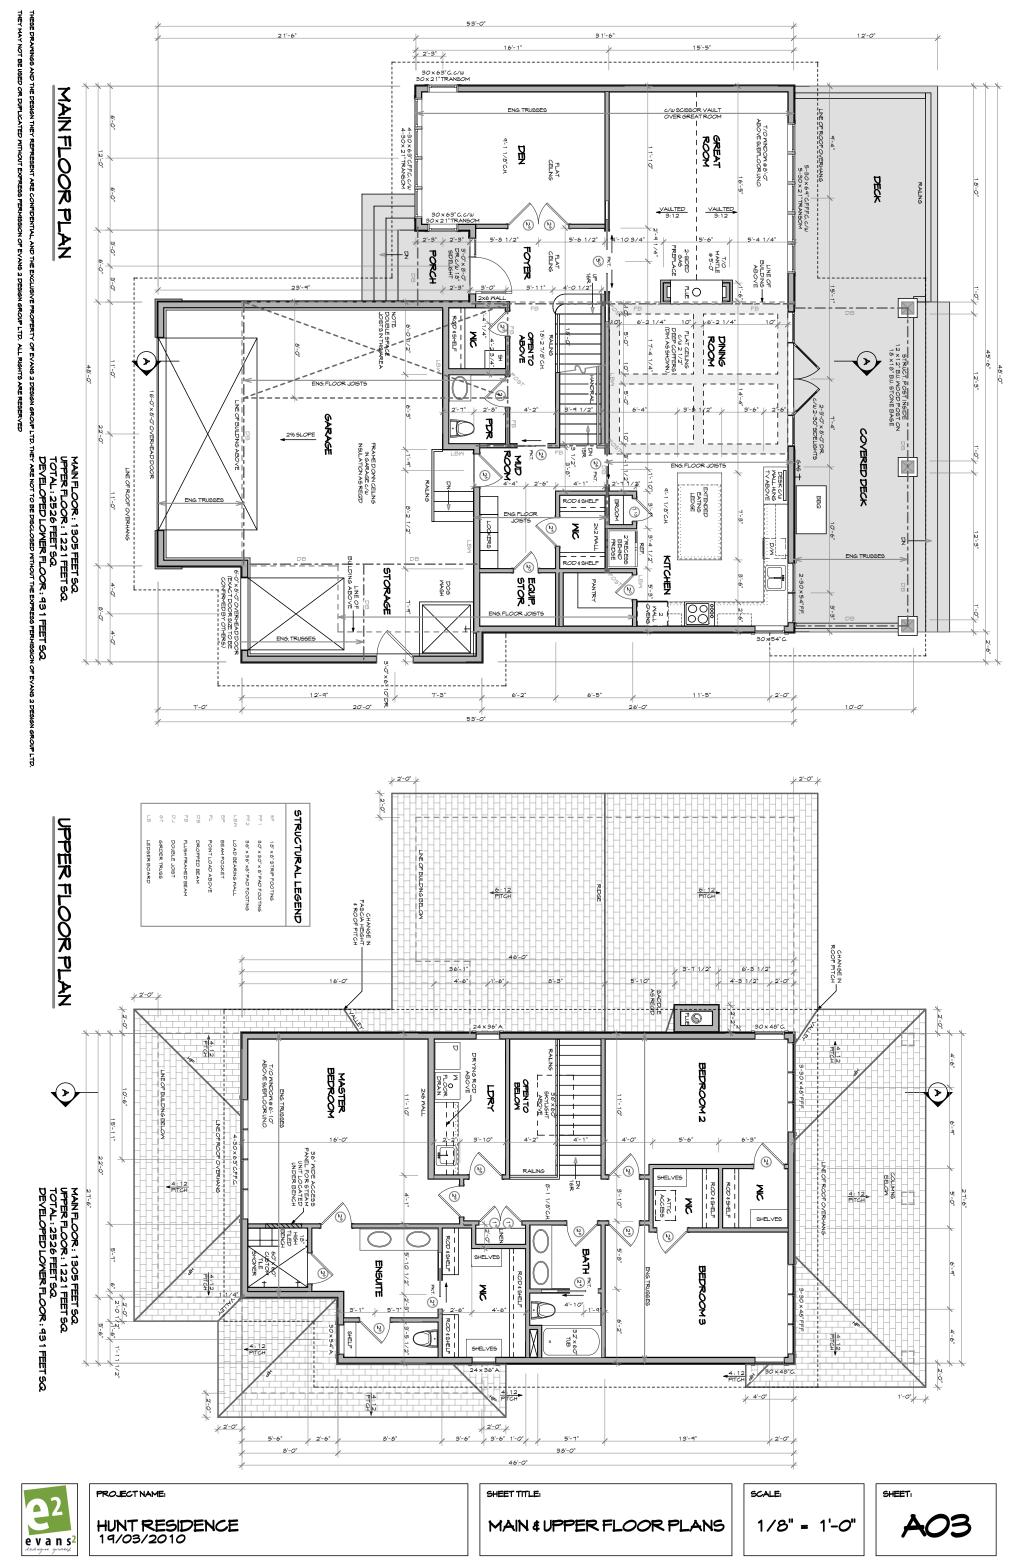

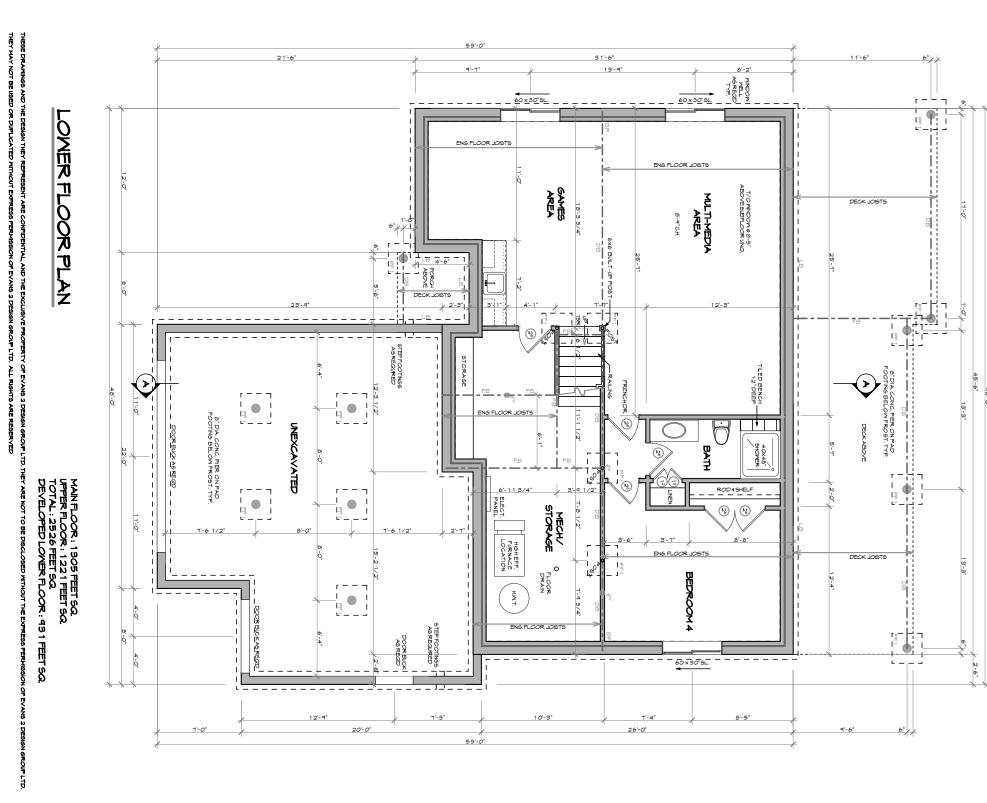

ROOFPLAN

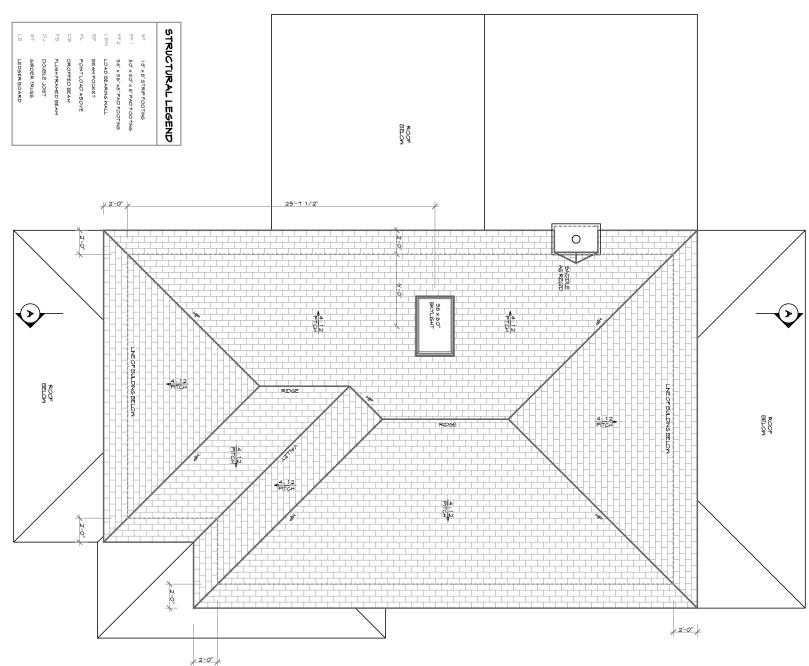





HUNT RESIDENCE 19/03/2010 LOWER FLOOR & ROOF PLANS

1/8" = 1'-0"

A04

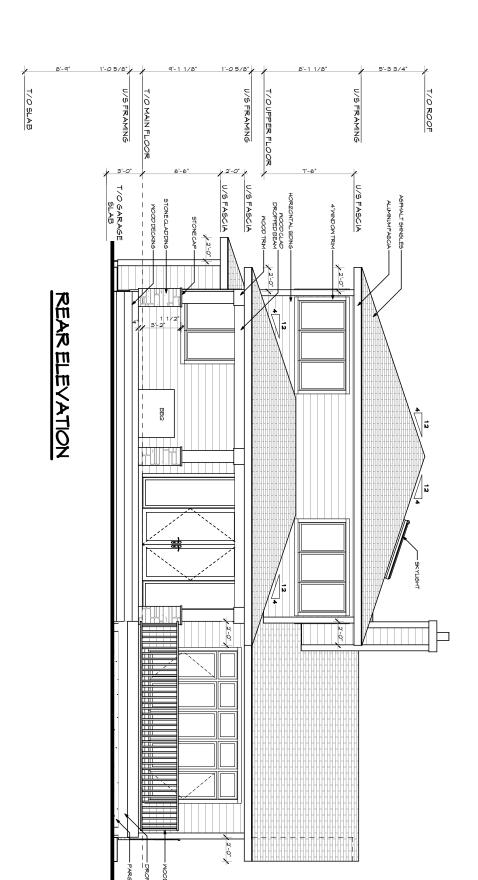

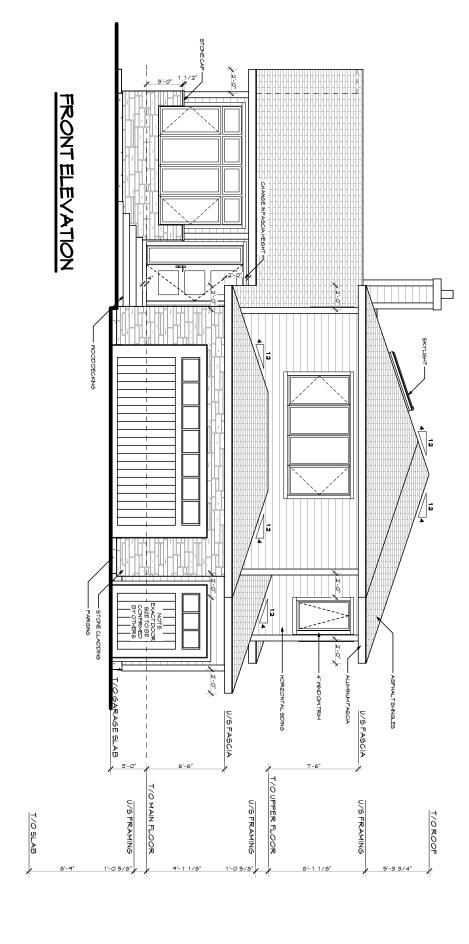

SECTION / ELEVATION NOTES

- PROVIDE FOUNDATION NANTERPROOFING WHERE EXTENDE GRADE IS ABOVE CRANK. PROJE OR BASERINT SLAB AND INSTALL FERFORATIOP PLAST COUNDATION UND AND SLOPE TO STORM SEMER, ON SITE DRY MELL OR NATURAL DRAINAGE COURSES. -GRADE ELEVATIONS SHOWN DO NOT NECESSARLLY REFER TO ANY SPECIFIC PIECE OF PROPERTY, THEY ARE FOR ILLUSTRATION PURPOSES ONLY AND WAY VARY. BUILDER IS RESPONDED FOR ADAPTING THESE DRAWINGS TO SUT THE EXSTING TOPOGRAPHY OF THE SITE.

BUILDER TO PROVIDE EXTREMOR INJUNIONA AND JONGS, AT CLAUMANES IN AT LICHANGES IN ATTEMAND, ADDOYS AT MUD MODES, AT CLAUMANES AND JONGS, AND JONGS, AT CLAUMANES AND JONGS, AT CLAUMANES AND JONGS, AT CLAUMANES AND JONGS, AND JONGS, AT CLAUMANES AND JONGS, AND JONGS

INNOW STILES AND SEES SHOWN, ARE TO BE USED AS A SUPELLY BY OUT, INACT, INNOW STILES AND SEES SHOWN, ARE TO BE USED AS A SUPELLY BY OUT INNOW STILES AND PROVIDED BY THE WINDOWN AND FACTURES AND PROVIDED BY THE WINDOWN AND FACTURES AND PROVIDED BY THE WINDOWN AND THE TEXT AND A CONTRACTOR OF SHOULD ALLAN WITH WINDOWS CONTRACTOR SHAWN AND SHOWN AND THE TEXT EXCESS AND THE FERED BY THE WINDOWS SHOWN AND WINDOWS AND THE TEXT EXCESS AND THE FERED BY THE WINDOWS SHOWN AND THE TEXT EXCESS AND THE FERED BY AND SHOWN AND THE TEXT EXCESS AND THE FERED BY AND SHOWN AND THE TEXT EXCESS AND SHOWN AND SHOWN AND THE TEXT EXCESS AND THE TEXT EXCESS AND SHOWN AND THE TEXT EXCESS AND T

-BUILDER 18 TO ENSURE THAT ROOF 18 ADEQUATELY VENTED AS PER LOCAL BULDING CODE : NETS HOT TO BE PLACED IN HIGH: LY VISIBLE LOCATIONS. DOWNSPOITS ARE NOT SHOWN FOR CLARITY, CONTRACTOR TO VERFY LOCATIONS WITH ONNER.


CHIMNEYS SHALL EXTEND AT LEAST 2-0' HIGHER THAN ANY PORTION OF THE BUILDING NITHN 10-0' OR AS PER LOCAL BUILDING CODE.






PROJECT NAME: HUNT RESIDENCE 19/03/2010 SHEET TITLE:

ELEVATIONS

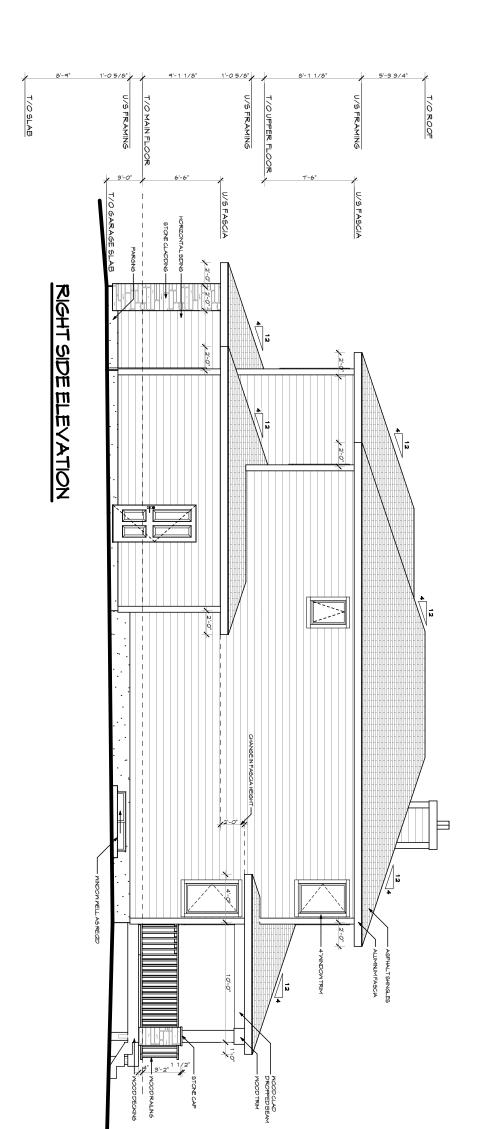

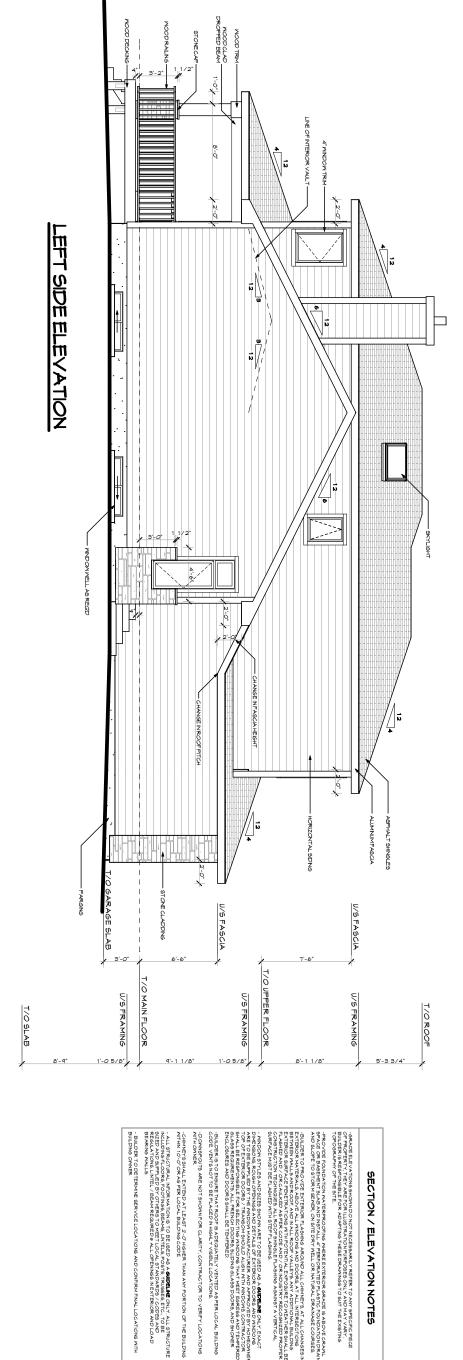

SECTION / ELEVATION NOTES

- PROVIDE FOUNDATION NANTERPROOFING WHERE EXTENDE GRADE IS ABOVE CRANK. PROJE OR BASERINT SLAB AND INSTALL FERFORATIOP PLAST COUNDATION UND AND SLOPE TO STORM SEMER, ON SITE DRY MELL OR NATURAL DRAINAGE COURSES. -GRADE ELEVATIONS SHOWN DO NOT NECESSARLLY REFER TO ANY SPECIFIC PIECE OF PROPERTY; HEY ARE FOR ILLUSTRATION PURPOSES ONLY AND MAY VARY. BUILDER IS RESPONSIBLE FOR ADAPTING THESE DRAWINGS TO SUIT THE EXSTING TOGGRAPHY OF THE SITE.

ILLI DER TO PROVIDE ENTEROR FLASHING ARCHIO ALL CHANGES IN TIREGE NATERIAL AND CONTROL OF THE CO

INNOW STILES AND SEES SHOWN, ARE TO BE USED AS A SUPELLY BY OUT, INACT, INNOW STILES AND SEES SHOWN, ARE TO BE USED AS A SUPELLY BY OUT INNOW STILES AND PROVIDED BY THE WINDOWN AND FACTURES AND PROVIDED BY THE WINDOWN AND FACTURES AND PROVIDED BY THE WINDOWN AND THE TEXT AND A CONTRACTOR OF SHOULD ALLAN WITH WINDOWS CONTRACTOR SHAWN AND SHOWN AND THE TEXT EXCESS AND THE FERED BY THE WINDOWS SHOWN AND WINDOWS AND THE TEXT EXCESS AND THE FERED BY THE WINDOWS SHOWN AND THE TEXT EXCESS AND THE FERED BY AND SHOWN AND THE TEXT EXCESS AND THE FERED BY AND SHOWN AND THE TEXT EXCESS AND SHOWN AND SHOWN AND THE TEXT EXCESS AND THE TEXT EXCESS AND SHOWN AND THE TEXT EXCESS AND T

-BUILDER 18 TO ENSURE THAT ROOF 18 ADEQUATELY VENTED AS PER LOCAL BULDING CODE : NETS HOT TO BE PLACED IN HIGH: LY VISIBLE LOCATIONS. DOWNSPOITS ARE NOT SHOWN FOR CLARITY, CONTRACTOR TO VERFY LOCATIONS WITH ONNER.

e v a n s

PROJECT NAME: HUNT RESIDENCE 19/03/2010 SHEET TITLE:

ELEVATIONS

1/8" = 1'-0"

-GRADE LECYATIONS SHOWN DO NOT TIECESSARLY REFER TO A MY SPECIFIC PROF OF PROPERTY THAT ARE FOR INJUSTRATION DIRPOSES ONLY AND MY VARY OFFICE BULIDER IS RESPONSIBLE FOR AD APTING THESE DRAWINGS TO SUIT THE EXISTING TOPOGRAPHY OF THE SITE.

-PROVIDE FOUNDATION MATERPROOPING WHERE EXTERIOR GRADE IS ADVICE CRANN. BPACE OR BASELVIT SLUB AND NOTAL "A "FERFORATIOD LASTIC DUINDATION DRANN AND SLOPE TO STORM SEMER, ON SITE DRY MELL OR NATURAL DRANNAGE COURSES. BUILDER (O PROVIDERXIEROR FLASHING AROUND ALL CHANGES AT ALL CHANGES IN XI EROR ANTERNAS ABOVE ALL MENDONS AND DOORS AT ALL MITTERSECTIONS SITTEEN WALLS AND ROOF, AND IN ALL ROOF, VALETYS ANY ADDITIONAL BUILDING XI EROR SURFACE PRETENTIONS AND THEOPTEN THE REPOSERET TO VEH HER SHALL ALL ALL SHOWN AND THE REPOSE AND THE PROPERTY OF T

OWN BY TUE AND SUBS SHOWN, ARE TO DE USED AS A SUPERING ON, TEXACT SOCIAL STORMS AND DETAILS OF EXTERNOR AND ASSETS AND STANDARD ASSETS OF EXTERNOR AND ASSETS AND ASSETT ASSETT ASSETT ASSETTS AND ASSETT ASSE

ō ¬

\(\)

BEDROOM 2

PKY F

MASTER

2-0"

(A)

2'-4"

-CHIMNEYS SHALL EXTEND AT LEAST 2-07 HIGHER THAN ANY PORTION OF THE BUILDING WITHN 1.0-07 OR AS PER LOCAL BUILDING CODE. -BUILDER IS TO ENSURE THAT ROOF IS ADEQUATELY VENTED AS PER LOCAL BUILDING CODE. VENTS NOTTO BE PLACED IN HIGHLY VISIBLE LOCATIONS.
-DOWNSPOLTS ARE NOT SHOWN FOR CLARITY, CONTRACTOR TO VERIFY LOCATIONS WITH OTWER. ALL STRUCTURAL INFORMATION IS TO BE USED AS A **GUPELNE** ONLY. ALL STRUCTURE LUDING-FLOORS, FOOTINGS BEAVEL, INFELS, FOST'S, TRUSEES, STC., TO BE ZED, AND SUPPLIED BY O'HER'S TO ARTIEL LOCAL STANDARDS / CODES AND SIGLATIONS. INFELS, PERAFRECQUIRED 9 ALL OPENNOS IN EXTENDER, AND LOAD ARRIVORALISE.

BUILDER TO DETERMINE SERVICE LOCATIONS AND CONFIRM FINAL LOCATIONS WITH SUILDING OWNER

J/S FASCIA

1-0

Z D E D E D 9-6

DINING ROOM

REYOND

(§

ORDER TRUSS

 $\begin{pmatrix} \mathbb{F} \\ 4 \end{pmatrix}$

<u>U</u> ∑

GARAGE WALLS TO BE DRYWALLED AND TAPED AS REQD FOR FUME BARRIER

GARAGE

FRAME DOWN CEILING N GARAGE C/W INSULATION AS REQ'D

CONSTRUCTION ASSEMBLIES

MALL ASSEMBLIES

NM 1 FROST WALL ASSEMBLY (WALK-OUT) RIGID INSULATION
8" CONCRETE FOUNDATION WALL
DAMPPROOFING

NM2 8" FROST WALL (GARAGE)

ANEA ANEA

(g)

MECH./ STORAGE

BUILDING SECTION "A"

SCALE 1/8" - 1'-0"

8" CONCRETE FOUNDATION WALL DAMPPROOFING (8" ABOVE FINISHED GRADE) PARGING (ABOVE FINISHED GRADE)

NM3 CONCRETE FOUNDATION WALL ASSEMBLY

1/2" GYPSUM BOARD WALL FINISH UNLESS NOTED OTHERWISE 6 MIL POLLY VAPOR BARRIER R-12 BATI INSULATION-UNLESS NOTED OTHERWISE 2X4 K.D. SPRUCE/PINE STUDS @ 16" o/c 1" AIR SPACE 8" CONCRETE FOUNDATION WALL DAMPPROOFING (8" ABOVE FINISHED GRADE) PARGING (ABOVE FINISHED GRADE)

NM4 CONCRETE FOUNDATION WALL ASSEMBLY w / FINISH

1/2" GYPSUM BOARD WALL FINISH UNLESS NOTED OTHER WISE 6 MIL POLLY VAPOR BARRIER R-12 BATTI NISULATION 224 K.D. SPRUCE/PINE STUDS @ 16" 0/6" 1" AIR SPRUCE FOUNDATION WALL 8" CONCRETE FOUNDATION WALL 9/6" EXTERIOR GRADE PLYMOOD SHEATHING BUILDING PAPER FINISH AS SPECIFIED

AMS EXTERIOR WALL ASSEMBLY

1/2" 6YPSUM BOARD WALL FINISH UNLESS NOTED OTHERWISE
6 MIL POLLY VAPOR BARRIER
R-20 BATTI NSULATION
2X6 K.D. SPRUCE/PINE STUDS @ 16" o/c (P.T. MATERIAL BELOW GRADE)
3/8" EXTERIOR GRADE PLYWOOD SHEATHING
BUILDING PAPER
FINISH AS SPECIFIED

1/2" GYPSUM BOARD WALL FINISH UNLESS NOTED OTHERWISE
(MOISTURE RESISTANT GYPSUM IN BATHROOMS - WONDER BOARD IN SHOWERS)
2X4 K.D. SPRUCE / PINE STUDS @ 16" O/C
ACOUSTICAL INSULATION INHERE APPLICABLE
1/2" GYPSUM BOARD WALL FINISH UNLESS NOTED OTHERWISE

1/2" GYPSUM BOARD WALL FINISH UNLESS NOTED OTHERWISE
(MOISTURE RESISTANT GYPSUM IN BATHROOMS - MONDER BOARD IN TILED SHOWERS)
2X6 KD.SPRUCE / PINE STUDS @ 16" 0/c
ACQUISTICAL INSULATION WHERE APPLICABLE
1/2" GYPSUM BOARD WALL FINISH UNLESS NOTED OTHERWISE

THESE DRAMINGS AND THE DESIGN THEY REPRESENT ARE COMPIDENTIAL, AND THE EXCLISIVE PROPERTY OF EVANS 2 DESIGN GROUP LTD. THEY ARE NOT TO BE DISCLOSED WITHOUT THE EXPRESS THEY MAY NOT BE USED OR DUPLICATED WITHOUT EXPRESS PERMISSION OF EVANS 2 DESIGN GROUP LTD. ALL RIGHTS ARE RESERVED

WM6 INTERIOR PARTITION WALL ASSEMBLY (2x4)

WMT INTERIOR PARTITION WALL ASSEMBLY (2x6) LOAD BEARING

FLOOR ASSEMBLIES

FF1 GARAGE SLAB ASSEMBLY (4") 4" CONCRETE SLAB - REINFORCED AS PER STRUCTURAL REQ. 4 SLOPED AS SPECIFIED 6 MIL POLY VAPOUR BARRIER 6" MIL YAPOUR DARRIER 6" MIL CLEAN, COMPACTED GRAVEL UNDISTURBED SOIL

FF2 BASEMENT ASSEMBLY

9" CONCRETE SLAB - REINFORCED AS PER STRUCTURAL REG. 6 MIL POLY VAPOUR BARRIER 6" MIN CLEAN, COMPACTED GRAVEL UNDISTURBED SOIL UNDISTURBED SOIL

FINISHED FLOOR AS SPECIFIED
(1/4* PLYWOOD UNDER TILED AREAS)
9/4* 166 EXTERIOR GRANDE FIR PLYWOOD (GLUED AND SCREMED)
1.JI FLOOR SYSTEM - AS PER STRUCTURAL REQ.
ACOUSTICAL INSULATION (WHERE APPLICABLE)
R-28 BATT INSULATION (CANTILEVERED FLOOR AREAS)
CROSS BRACING AS REQ'D
1/2 'CD SYFSUM BOARD OR 5/8' GYPSUM BOARD (INTERIOR SPACE)
FINISH AS SPECIFIED (INTERIOR SPACE)
FINISH AS SPECIFIED (INTERIOR SPACE)

FF5 EXTERIOR DECK ASSEMBLY OPTION B

DURADECK FINISH
30.4" 146 EXTERIOR GRADE FIR PLYMOOD (GLUED & SCREMED)
MOOD JOISTS - AS PER STRUCTURAL REQ. (SLOPED)
CROSS BRACING AS REQU
ALUMINUM VENTED SOFFIT

FF3 RESIDENCE FLOOR ASSEMBLY

1 1/4" EXTERIOR GRADE WOOD DECKING WOOD JOISTS - AS PER STRUCTURAL REQ

FF4 EXTERIOR DECK ASSEMBLY OPTION A

FF6 EXTERIOR DECK ASSEMBLY OPTION C

TILE FNISH AS SPECIFIED (WHERE APPLICABLE)
CONCRETE TOPPING - REINFORCED AS PER STRUCT REQ. (SLOPED.)
WATERPROOF MEMBRANG (WHERE APPLICABLE)
3 A' 146 EXTERIOR GRADE FIR PL YWOOD (SLUED & SCREMED.)
WOOD JOISTS - AS PER STRUCTURAL REQ.
R-28 BATT INSULATION (IF HEATED SPACE BELOW)
1/2 CD SYPSUM BOARD OR 5/8 SYPSUM BOARD (INTERIOR SPACE)
FNISH AS SPECIFIED (NITERIOR SPACE)
FNISH AS SPECIFIED (NITERIOR SPACE)

(EXTERIOR SPACE BELOW) (WHERE APPLICABLE)

FF7 PATIO SLAB ASSEMBLY

4" CONCRETE SLAB - REINFORCED AS PER STRUCTUR AL DRAMINGS 6 MIL POLY VAPOUR BARRIER 6" MIN CLEAN, COMPACTED GRAVEL UNDISTURBED SOIL

ROOF ASSEMBLIES

RR 1 ROOF ASSEMBLY - SLOPED

FINISHED ROOFING AS SPECIFIED (CEDAR SHAKES)
BUILDING PAPER

9/8' EXTERUOR GRADE ROOF SHEATHING C/WH CLIPS
PRE-ENGINEERED ROOF JUSTS / TRUSSES (SEE STRUCTURAL)
MINIMUM R-40 BATT INSULATION (ABOVE LIVING SPACE)
6 MIL POLY VAPOUR BARRIER (ABOVE LIVING SPACE)
1/2' CD GYPSUM BOARD OR 5/5' GYPSUM BOARD
ALUMINUM VENTED SOFFIT ® EAVES

evans

PROJECT NAME: HUNT RESIDENCE 19/03/2010

SHEET TITLE:

T/O SLAB

BUILDING SECTIONS

SCALE:


U/S FRAMING


T/0 R00F

(Z)

U/S FRAMING

MAIN FLOOR ELECTRICAL PLAN

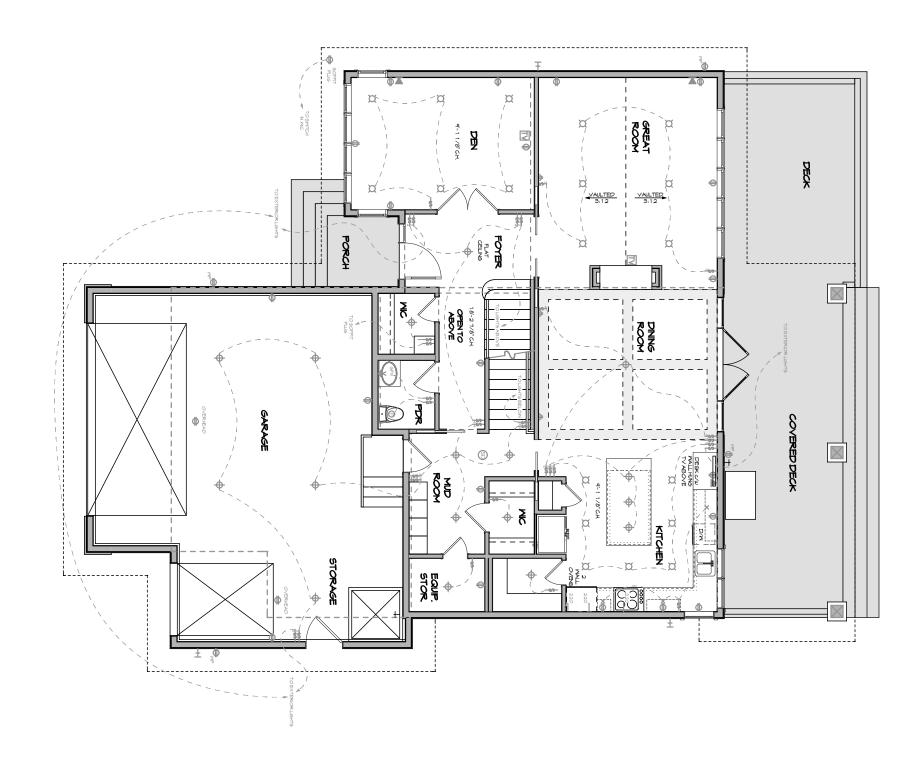

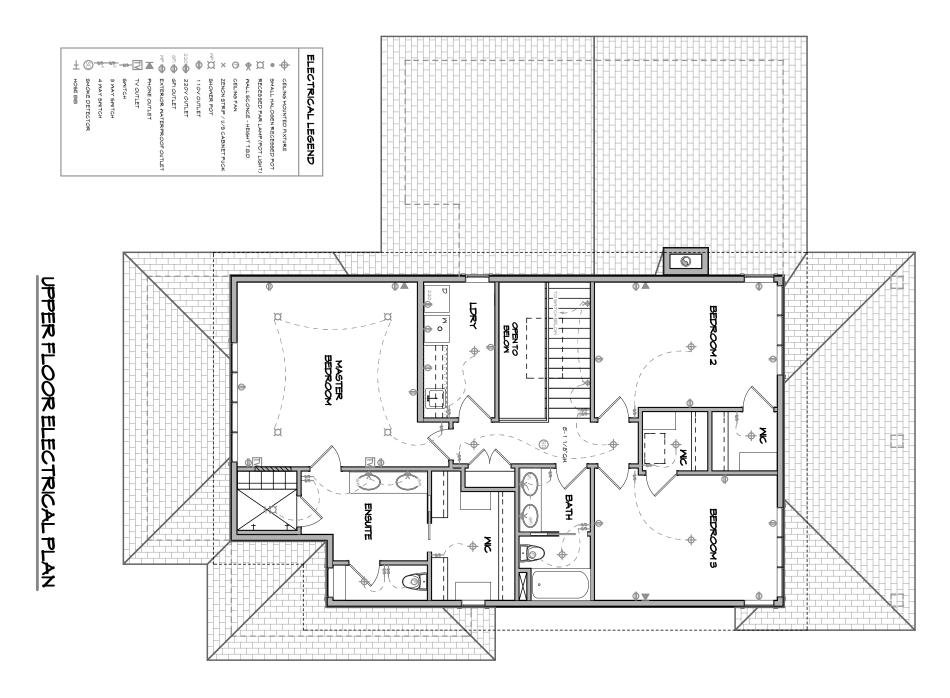



HUNT RESIDENCE 19/03/2010 SHEET TITLE:


MAIN & UPPER ELECTRICAL


SCALE:

1/8" = 1'-0"

EO 1

LOWER FLOOR ELECTRICAL PLAN

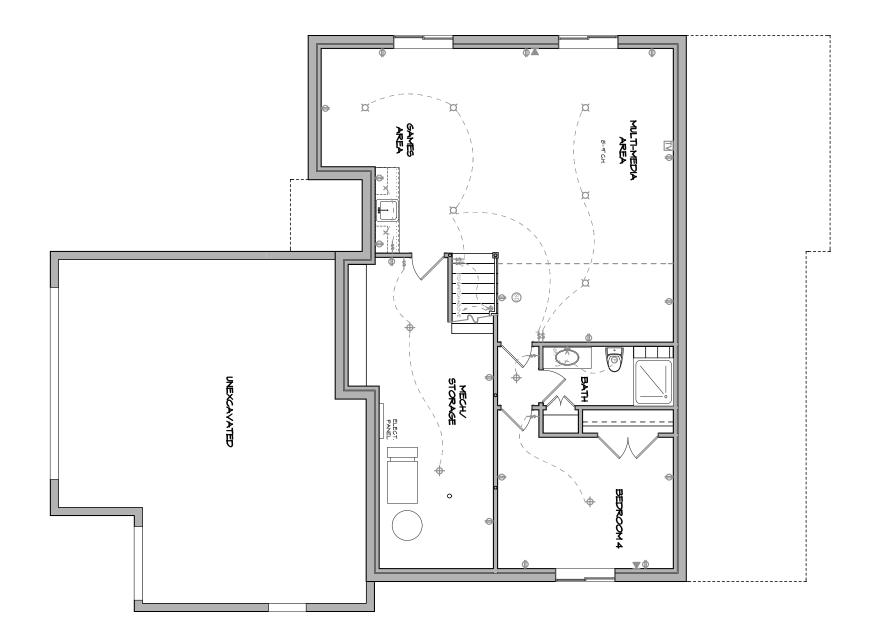

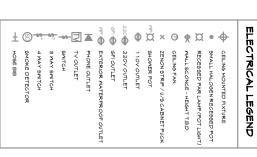



HUNT RESIDENCE 19/03/2010 SHEET TITLE:

LOWER FLOOR ELECTRICAL

SCALE:

1/8" = 1'-0"

E02